



REVISIONS

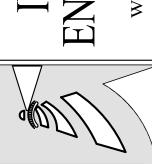


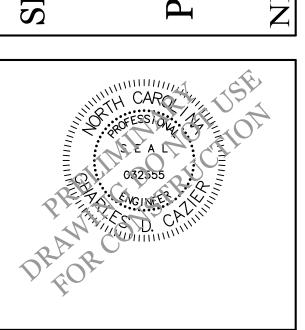

CLIENT INFORMATION: Peace Baptist Church, Inc of Wilmington, North Carolina Pastor Rudy Shepard 320 Military Cutoff Rd. Wilmington NC 28403 910-791-4034 preachershepard@bellsouth.net

	DRAWN:	JAE	SHEET SIZE:	24x36
	CHECKED:	CDC	DATE:	3/21/2019
	APPROVED:	CDC	SCALE:	1" = 30'
l	PROJECT NUMBER:		2017-019	

DRAWING NUMBER: C-1

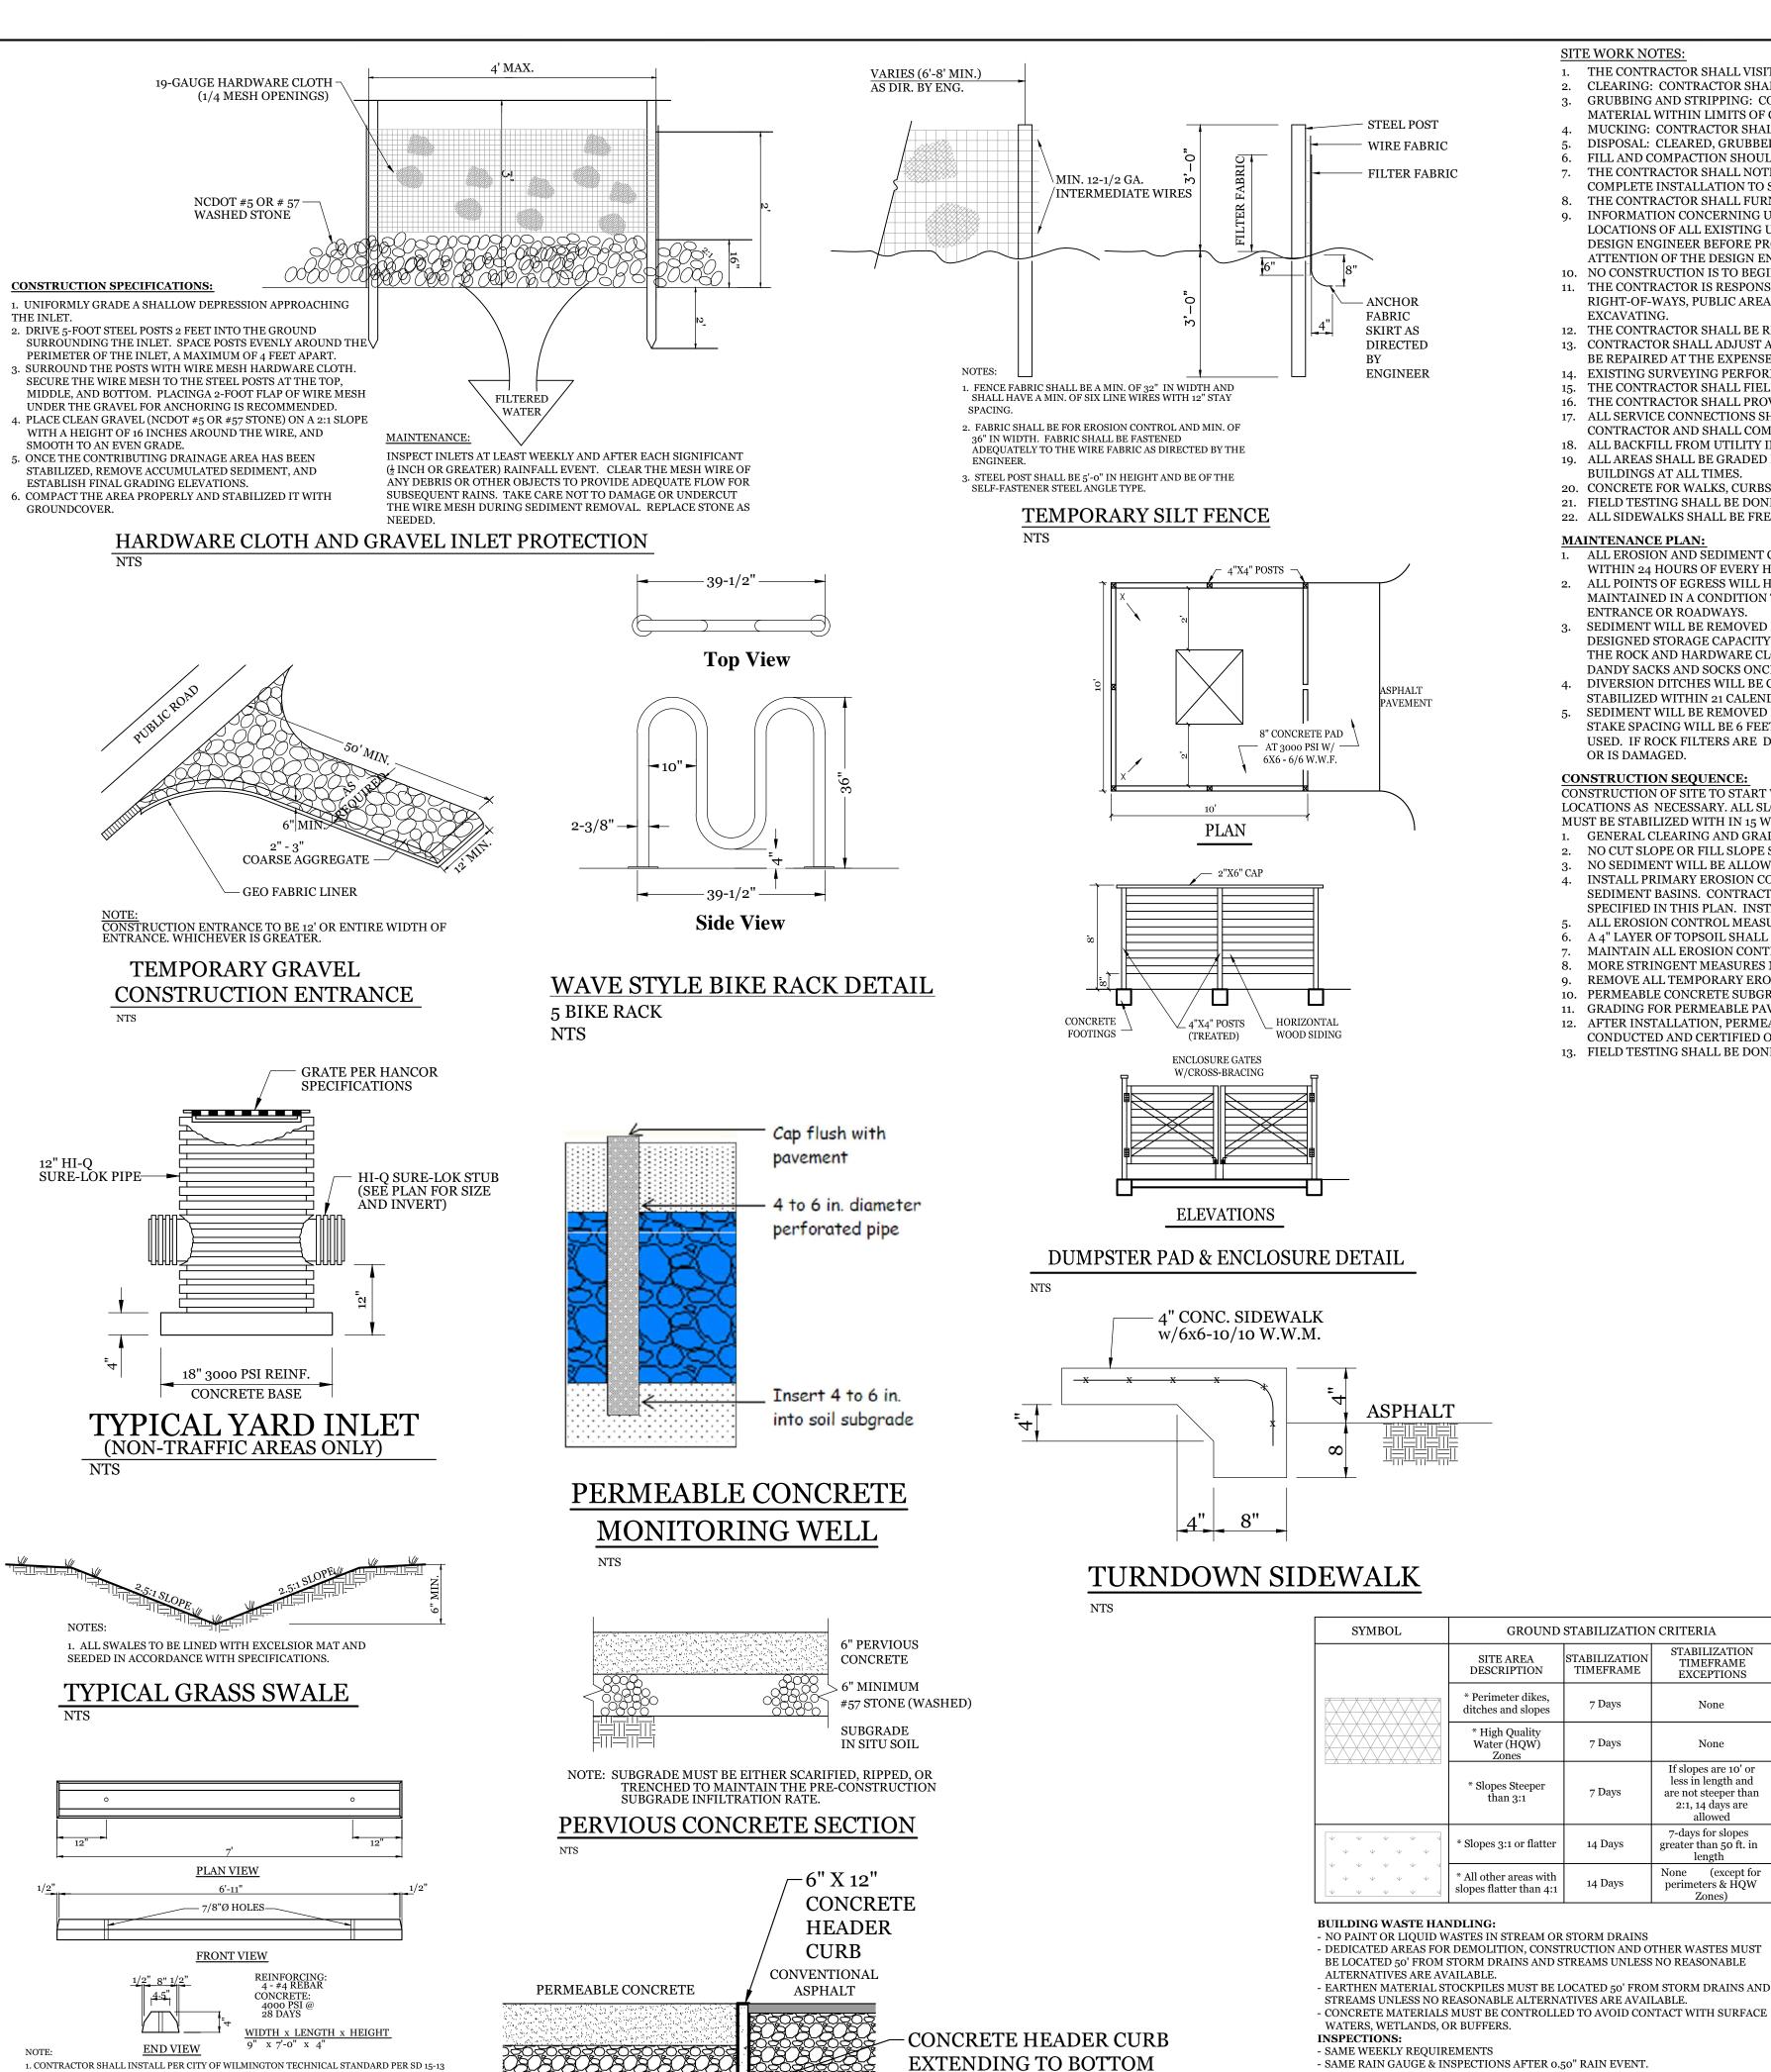

PERMEABLE CONCRETE BORDER

OF PERMEABLE BASE

2. CONTRACTOR SHALL INSTALL WHEEL STOP 2.5' FROM SIDEWALK.

WHEEL STOP DETAIL

SITE WORK NOTES:

- THE CONTRACTOR SHALL VISIT THE SITE AND BECOME FAMILIAR WITH EXISTING CONDITIONS BOTH ON AND ADJACENT TO THE SITE.
- CLEARING: CONTRACTOR SHALL REMOVE ALL TREES AND VEGETATION WITHIN LIMITS OF CONSTRUCTION UNLESS OTHERWISE DESIGNATED TO REMAIN. GRUBBING AND STRIPPING: CONTRACTOR SHALL RAKE AND REMOVE ROOTS, STUMPS, VEGETATION, DEBRIS, EXISTING STRUCTURES ABOVE AND BELOW GRADE, ORGANIC MATERIAL OR ANY OTHER UNSUITABLE
- MUCKING: CONTRACTOR SHALL COORDINATE WITH OWNER AND THEIR GEOTECHNICAL REPRESENTATIVE TO COORDINATE REMOVAL OF ANY SOFT AREAS.
- DISPOSAL: CLEARED, GRUBBED, STRIPPED OR OTHER WASTE MATERIAL SHALL BE REMOVED FROM SITE AND DISPOSED OF IN A PROPERLY PERMITTED FACILITY
- FILL AND COMPACTION SHOULD COMPLY WITH GEOTECHNICAL RECOMMENDATIONS THE CONTRACTOR SHALL NOTE THAT THE GRADING PLAN MAY NOT REPRESENT A BALANCED EARTHWORK CONDITION. THE CONTRACTOR SHALL BE RESPONSIBLE FOR CUT AND FILL QUANTITIES AND
- COMPLETE INSTALLATION TO SPECIFIED GRADES.
- 8. THE CONTRACTOR SHALL FURNISH SUITABLE BORROW MATERIAL FROM AN OFF-SITE PROPERLY PERMITTED FACILITY AS REQUIRED. LOCATIONS OF ALL EXISTING UTILITIES AT ALL CROSSINGS PRIOR TO COMMENCING TRENCH EXCAVATION. IF ACTUAL CLEARANCES ARE LESS THAN INDICATED ON PLAN, THE CONTRACTOR SHALL CONTACT THE
- 10. NO CONSTRUCTION IS TO BEGIN BEFORE LOCATION OF EXISTING UTILITIES HAS BEEN DETERMINED. CALL "NC ONE-CALL" AT LEAST 48 HOURS BEFORE COMMENCING CONSTRUCTION. 11. THE CONTRACTOR IS RESPONSIBLE FOR THE LOCATION AND PROTECTION OF ALL EXISTING UTILITIES DURING CONSTRUCTION. BEFORE COMMENCING ANY EXCAVATIONS IN OR ALONG ROADWAYS OR
- 12. THE CONTRACTOR SHALL BE RESPONSIBLE TO COORDINATE DISCONNECTION/ RECONNECTION AND/OR THE RELOCATION OF ALL EXISTING UTILITIES WITH APPROPRIATE PERSONNEI
- 13. CONTRACTOR SHALL ADJUST ALL MANHOLES, VALVE & CURB BOXES TO FINAL GRADE UPON COMPLETION OF ALL CONSTRUCTION. ANY BOXES DAMAGED OR OTHERWISE DISTURBED BY THE CONTRACTOR SHALL BE REPAIRED AT THE EXPENSE OF THE CONTRACTOR.
- 14. EXISTING SURVEYING PERFORMED BY STUART Y. BENSON, N.C. PLS L-2675 15. THE CONTRACTOR SHALL FIELD VERIFY ALL DIMENSIONS AT THE SITE. FURTHERMORE THE CONTRACTOR SHALL REPORT ALL DISCREPANCIES OR QUESTIONS TO THE ENGINEER PRIOR TO INSTALLATION.
- 6. THE CONTRACTOR SHALL PROVIDE ANY AND ALL LAYOUT REQUIRED TO CONSTRUCT HIS WORK UNLESS OTHERWISE DIRECTED BY OWNER. 17. ALL SERVICE CONNECTIONS SHALL BE INSTALLED TO MEET ALL LOCAL, STATE, AND CFPUA CODES. METERS, TAPS, MATERIALS, WORKMANSHIP AND ALL FEES SHALL BE THE RESPONSIBILITY OF THE
- CONTRACTOR AND SHALL COMPLY WITH ALL REQUIREMENTS 18. ALL BACKFILL FROM UTILITY INSTALLATION MUST BE COMPACTED OR AMENDED TO PROVIDE TRAFFIC BEARING CAPACITY. GEOTECHNICAL ENGINEER TO BE CONSULTED AT CONTRACTORS COST AS NECESSARY.
- 19. ALL AREAS SHALL BE GRADED FOR POSITIVE DRAINAGE. CONTRACTOR SHALL REPORT ANY DISCREPANCIES TO THE ENGINEER PRIOR TO INSTALLATION. ALL AREAS SHALL BE SLOPED TO DRAIN AWAY FROM
- 20. CONCRETE FOR WALKS, CURBS AND DRIVES SHALL HAVE A MINIMUM COMPRESSIVE STRENGTH OF 3000 PSI @ 28 DAYS AIR ENTRAINED
- 21. FIELD TESTING SHALL BE DONE BY AN INDEPENDENT TESTING LABORATORY PAID FOR BY THE OWNER. FURTHER TESTING REQUIRED DUE TO A FAILED TEST WILL BE PAID FOR BY THE CONTRACTOR. 22. ALL SIDEWALKS SHALL BE FREE OF CRACKS, BREAKS, OR ANY OTHER DEFECT PRIOR TO RECEIVING A CERTIFICATE OF OCCUPANCY.

- 1. ALL EROSION AND SEDIMENT CONTROL PRACTICES WILL BE CHECKED FOR STABILITY AND OPERATION FOLLOWING EVERY RUNOFF-PRODUCING RAINFALL, BUT IN NO CASE, LESS THAN ONCE EVERY WEEK AND WITHIN 24 HOURS OF EVERY HALF INCH RAINFALL
- 2. ALL POINTS OF EGRESS WILL HAVE CONSTRUCTION ENTRANCES THAT WILL BE PERIODICALLY TOP-DRESSED WITH AN ADDITIONAL 2 INCHES OF 2-3 INCH STONE TO MAINTAIN PROPER DEPTH. THEY WILL BE MAINTAINED IN A CONDITION TO PREVENT MUD OR SEDIMENT FROM LEAVING THE SITE. IMMEDIATELY REMOVE OBJECTIONABLE MATERIAL SPILLED, WASHED OR TRACKED ONTO THE CONSTRUCTION
- DESIGNED STORAGE CAPACITY HAS BEEN HALF FILLED WITH SEDIMENT. ROCK WILL BE CLEANED OR REPLACED WHEN THE SEDIMENT POOL NO LONGER DRAINS AS DESIGNED. DEBRIS WILL BE REMOVED FROM THE ROCK AND HARDWARE CLOTH TO ALLOW PROPER DRAINAGE. SILT SACKS WILL BE EMPTIED ONCE A WEEK AND AFTER EVERY RAIN EVENT. SEDIMENT WILL BE REMOVED FROM AROUND BEAVER DAMS,
- DANDY SACKS AND SOCKS ONCE A WEEK AND AFTER EVERY RAIN EVENT. 4. DIVERSION DITCHES WILL BE CLEANED OUT IMMEDIATELY TO REMOVE SEDIMENT OR OBSTRUCTIONS FROM THE FLOW AREA. THE DIVERSION RIDGES WILL ALSO BE REPAIRED. SWALES MUST BE TEMPORARILY
- STABILIZED WITHIN 21 CALENDAR DAYS OF CEASE OF ANY PHASE OF ACTIVITY ASSOCIATED WITH A SWALE. SEDIMENT WILL BE REMOVED FROM BEHIND THE SEDIMENT FENCE WHEN IT BECOMES HALF FILLED. THE SEDIMENT FENCE WILL BE REPAIRED AS NECESSARY TO MAINTAIN A BARRIER. STAKES MUST BE STEEL. STAKE SPACING WILL BE 6 FEET MAX. WITH THE USE OF EXTRA STRENGTH FABRIC, WITHOUT WIRE BACKING. STAKE SPACING WILL BE 8 FEET MAX WHEN STANDARD STRENGTH FABRIC AND WIRE BACKING ARE USED. IF ROCK FILTERS ARE DESIGNED AT LOW POINTS IN THE IN THE SEDIMENT FENCE THE ROCK WILL BE REPAIRED OR REPLACED IF IT BECOMES HALF FULL OF SEDIMENT, NO LONGER DRAINS AS DESIGNED

- CONSTRUCTION OF SITE TO START WITH INSTALLATION OF CONSTRUCTION ENTRANCE AND SILT FENCE ALONG ALL LOCATIONS PER PLANS. UPON INSTALLATION OF SILT FENCE, TREES SHOULD BE REMOVED IN LOCATIONS AS NECESSARY. ALL SLOPED AREAS SHOULD BE SEEDED IN ACCORDANCE TO SPECIFICATIONS. SLOPE STABILIZATION IS WITHIN 21 CALENDAR DAYS OF ANY PHASE OF CONSTRUCTION. ALL OTHER AREAS
- 1. GENERAL CLEARING AND GRADING OF THIS SITE WILL NOT BE DONE UNTIL THE TEMPORARY SILT FENCE & CONSTRUCTION ENTRANCE HAS BEEN INSTALLED.
- 2. NO CUT SLOPE OR FILL SLOPE SHALL EXCEED A RISE OR FALL OF ONE FOOT FOR EVERY RUN OF 3 FEET (1 VERTICAL TO 3 HORIZONTAL).
- INSTALL PRIMARY EROSION CONTROL MEASURES BEFORE BEGINNING CONSTRUCTION INCLUDING BUT NOT LIMITED TO GRAVELED CONSTRUCTION ENTRANCE, SILT FENCE, TREE PROTECTION FENCE &
- SEDIMENT BASINS. CONTRACTOR TO BE FAMILIAR WITH USACOE GENERAL PERMIT CONDITIONS FOR ROAD CROSSINGS. SPECIFIC CONSTRUCTION METHODS MAY BE REQUIRED ABOVE AND BEYOND WHAT IS SPECIFIED IN THIS PLAN. INSTALL ALL SECONDARY EROSION CONTROL MEASURES, SUCH AS INLET PROTECTION AS SOON AS POSSIBLE AFTER BEGINNING CONSTRUCTION ALL EROSION CONTROL MEASURES TO BE INSPECTED AFTER EACH RAIN. SILT FENCE AND INLET PROTECTION TO BE CLEANED WHEN HALF FULL
- A 4" LAYER OF TOPSOIL SHALL BE APPLIED TO ALL NEW AREAS TO BE GRASSED
- MAINTAIN ALL EROSION CONTROL MEASURES UNTIL PROJECT IS COMPLETE MORE STRINGENT MEASURES MAY BE REQUIRED TO HALT EROSION IF THOSE ON THIS PLAN PROVE TO BE LESS EFFECTIVE
- REMOVE ALL TEMPORARY EROSION CONTROL MEASURES UPON COMPLETION OF CONSTRUCTION. ALL PERMANENT MEASURES SHALL BE WELL ESTABLISHED PRIOR TO PROJECT COMPLETION.
- 10. PERMEABLE CONCRETE SUBGRADE MUST BE EITHER SCARIFIED, RIPPED, OR TRENCHED TO MAINTAIN THE PRE-CONSTRUCTION SUBGRADE INFILTRATION RATE. 11. GRADING FOR PERMEABLE PAVEMENT TO BE COMPLETED DURING DRY WEATHER.
- 12. AFTER INSTALLATION, PERMEABLE PAVEMENT SHALL BE PROTECTED FROM SEDIMENT DEPOSITION UNTIL THE SITE IS COMPLETED AND STABILIZED. AN IN-SITU INFILTRATION PERMEABILITY TEST SHALL BE CONDUCTED AND CERTIFIED ON THE PAVEMENT AFTER SITE STABILIZATION
- 13. FIELD TESTING SHALL BE DONE BY AN INDEPENDENT TESTING LABORATORY PAID FOR BY THE OWNER. FURTHER TESTING REQUIRED DUE TO A FAILED TEST WILL BE PAID FOR BY THE CONTRACTOR.

NORTH CAROLINA TEMPORARY

SEEDING MIXTURE SPECIES APPLICATION RATE

LATE WINTER & EARLY SPRING: Rye (grain)

of temporary cover is not to extend beyond June

100 (lb/acre) Annual Iespedeza (Kobe in Piedmont and Coastal Plain, Korean in Mountains) 50 (lb/acre) Omit annual Iespedeza when duration

SUMMER: German Millet

In the Piedmont and Mountains 40 (lb/acre) a small-stemmed sundangrass may be substituted at a rate of 50 (lb/acre)

FALL: Rye (grain) 120 (lb/acre)

SEEDING DATES

LATE WINTER & EARLY SPRING:

Mountains - Above 2500 ft: Feb. 15-May 15 Piedmont - Jan. 1-May 1 Coastal Plain - Dec. 1-Apr. 15

Coastal Plain and Piedmont - Aug. 15-Dec. 30

SUMMER:

Mountains - May 15-Aug. 15 Piedmont - May 1-Aug. 15 Coastal Plain - Apr. 15-Aug. 15

STABILIZATION

TIMEFRAME

None

If slopes are 10' or

less in length and

are not steeper than

2:1, 14 days are

allowed

7-days for slopes

greater than 50 ft. in

length

perimeters & HQW

None (except for

ΓIMEFRAME

7 Days

7 Days

7 Days

14 Days

INSPECTIONS ARE ONLY REQUIRED DURING "NORMAL BUSINESS HOURS"

- RECORDS MUST BE KEPT FOR 3 YEARS AND AVAILABLE UPON REQUEST.

UNLESS A SITE-SPECIFIC EXEMPTION IS APPROVED.

DRAINAGE AREA IS LESS THAN 1 ACRE.

- USE ONLY DWQ APPROVED FLOCCULANTS

INSPECTION REPORTS MUST BE AVAILABLE ON-SITE DURING BUSINESS HOURS

- ELECTRONICALLY AVAILABLE RECORDS MAY BE SUBSTITUTED UNDER CERTAIN

- OUTLET STRUCTURES MUST BE WITHDRAWN FROM BASIN SURFACES UNLESS

Mountains - Aug. 15-Dec. 15

SOIL AMENDMENTS:

Follow recommendations of soil tests or apply 2,000 lb/acre ground agricultural limestone and 750 lb/acre 10-10-10 fertilizer.

MULCH:

apply 4,000 lb/acre straw. anchor straw by tacking with asphalt, netting, or a mulch anchoring tool. A disk with blades set nearly straight can be used as a mulch anchoring tool.

Refertilize if growth is not fully adequate. reseed, refertilize and mulch immediately following erosion or other damage.

NORTH CAROLINA PERMANENT **GRASSING DETAIL**

SEEDING MIXTURE SPECIES APPLICATION RATE

50 (lb/acre)

FALL & WINTER: Tall Fescue (blend of two or 200 (lb/acre)

three improved varieties) Rye (grain) 25 (lb/acre) **SPRING & SUMMER**

Sericea Lespedeza 30 (lb/acre) Common Bermudagrass 10 (lb/acre) German Millet 10 (lb/acre) Tall Fescue 50 (lb/acre)

SEEDING DATES

August - December

Pensacola Bahiagrass

FALL & WINTER: January - April

SOIL AMENDMENTS:

Apply lime and fertilizer according to soil tests, or apply 3.000-5,000 lb/acre ground agricultural limestone (use the lower rate on sandy soils) and 1,000 lb/acre 10-10-10 fertilizer.

MAINTENANCE:

Fertilize according to soil tests or apply 40 lb/acre nitrogen in January or february, 40 lb in September and 40 lb in November, from a 12-4-8, 16-4-8, or similar turf fertilizer. Avoid fertilizer applications during warm weather, as this increases stand losses to disease. Reseed, fertilize, and mulch damaged areas immediately. mow to a height of 2.5-3.5 inches as needed.

SPRING & SUMMER:

April 1 - July 15 **SOIL AMENDMENTS:**


Apply lime and fertilizer according to soil tests, or apply 3,000 lb/acre ground


agriculture limestone and 500 lb/acre 10-10-10 fertilizer.

MAINTENANCE:


Refertilize the following april with 50 lb/acre nitrogen. Repeat as growth requires. may be moved only once a year. Where a neat appearance is desired, omit sericea and mow as often as needed.

apply 4,000 lb/acre straw. anchor straw by tacking with asphalt, netting, or a mulch anchoring tool. A disk with blades set nearly straight can be used as a mulch anchoring tool.

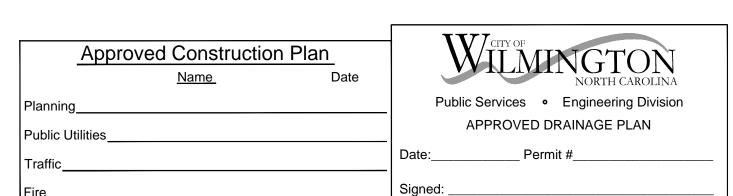

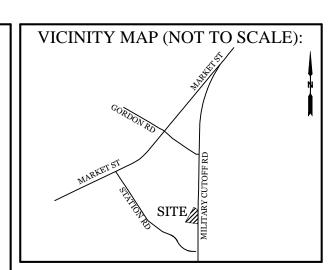


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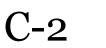
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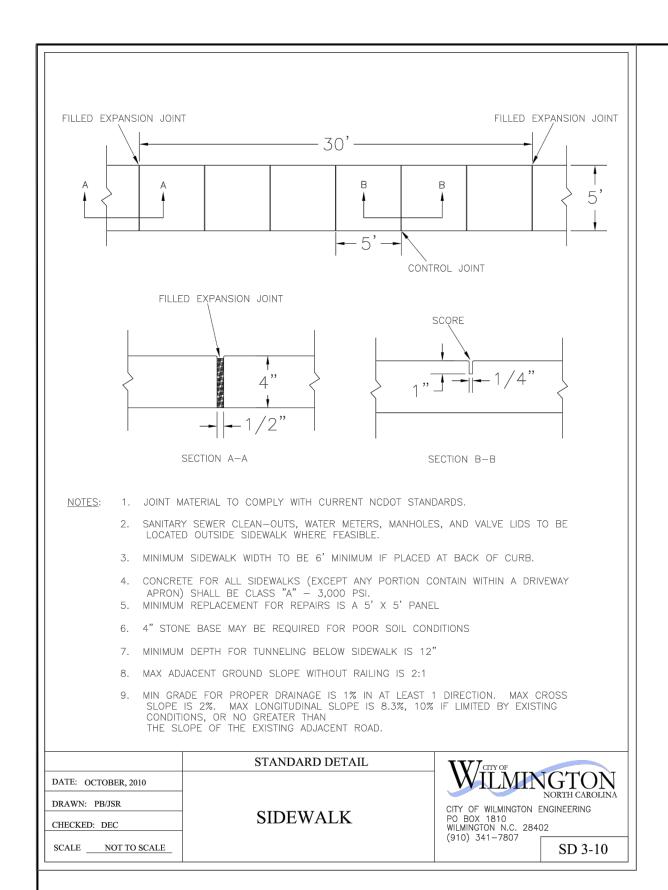


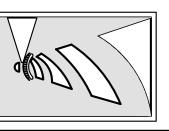
CLIENT INFORMATION: Peace Baptist Church, Inc of Wilmington, North Carolina Pastor Rudy Shepard 320 Military Cutoff Rd. Wilmington NC 28403 910-791-4034 preachershepard@bellsouth.net


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	CHECKED:	CDC	DATE:	3/21/2019
ı	APPROVED:	CDC	SCALE:	NTS
ı	PROJECT NUMBER:		2017-019	

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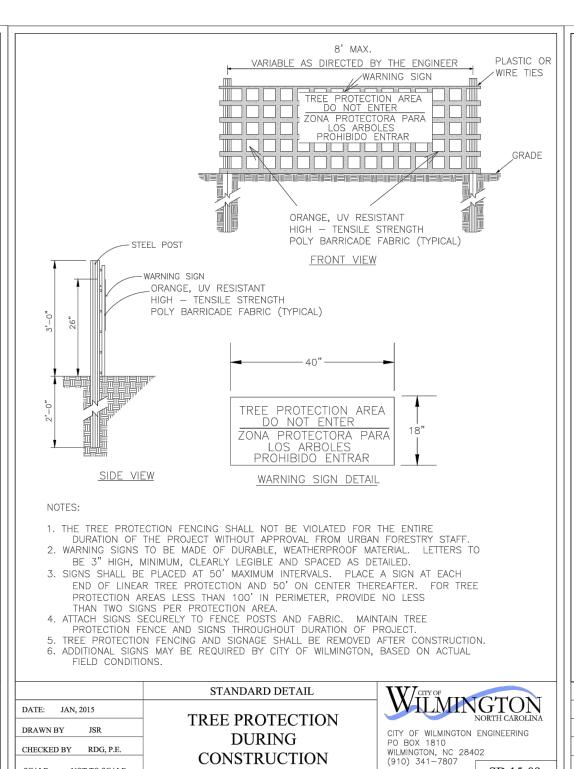


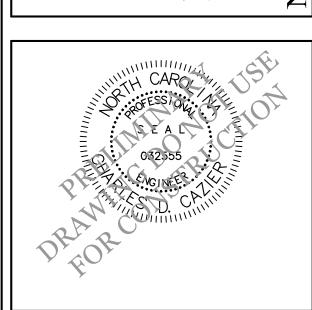

SHEET 1 of 2

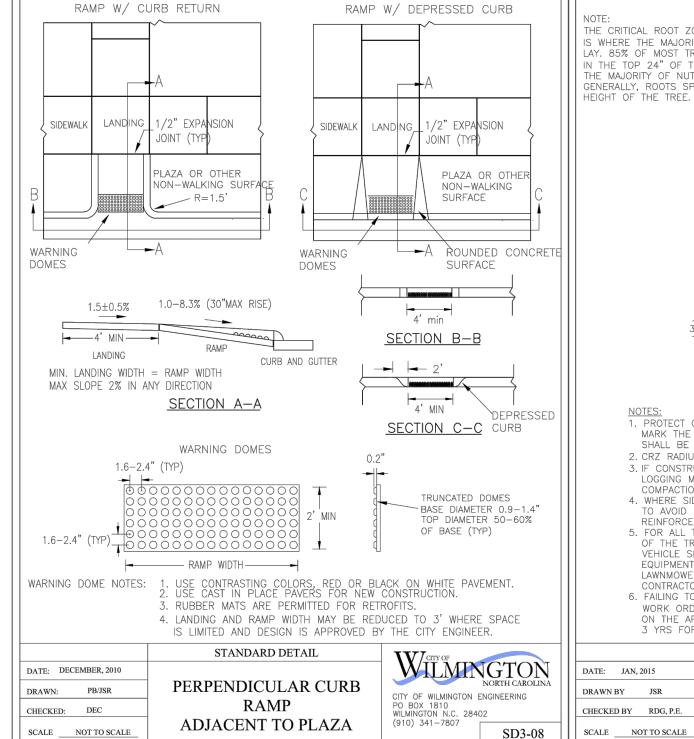SD 15-09

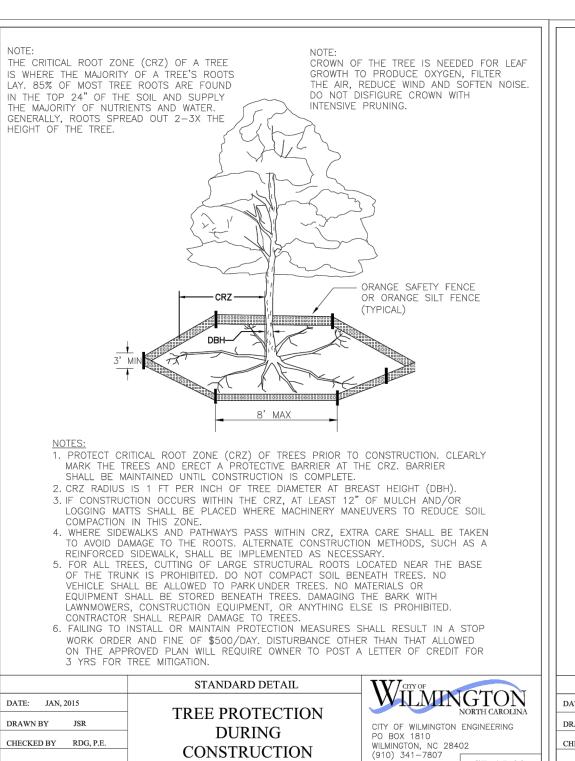SCALE NOT TO SCALE





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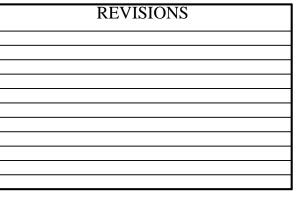
SHEET 2 of 2

SD 15-09

SCALE NOT TO SCALE



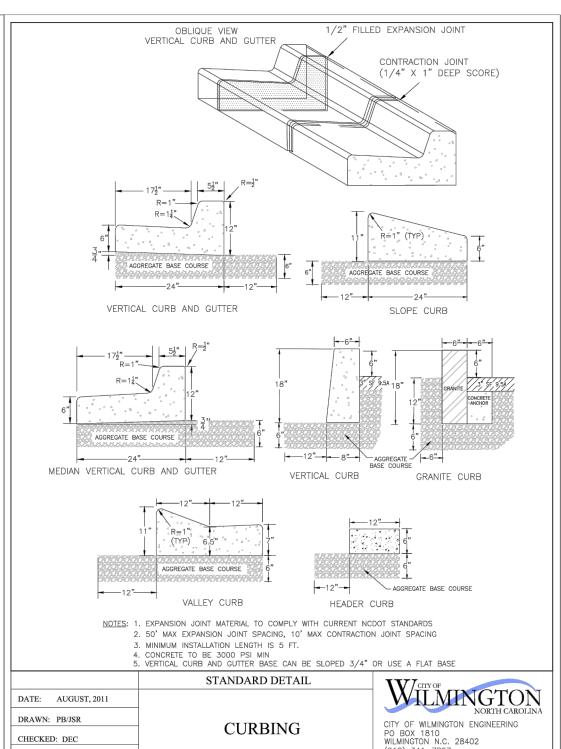


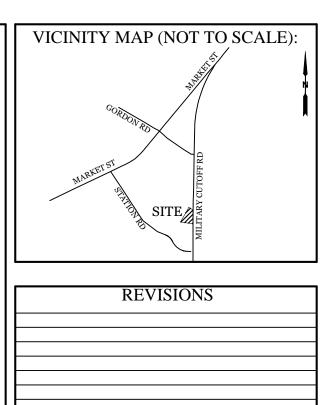

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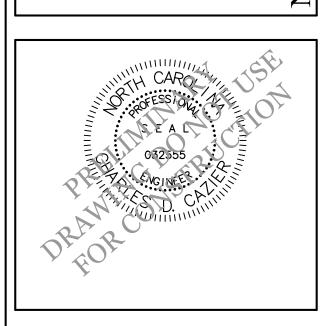
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of Wilmington, North Carolina Pastor Rudy Shepard 320 Military Cutoff Rd. Wilmington NC 28403 910-791-4034 preachershepard@bellsouth.net JAE | SHEET SIZE: DRAWN:

CLIENT INFORMATION: Peace Baptist Church, Inc

CDC DATE: CHECKED: 3/21/2019 CDC | SCALE: APPROVED: NTS PROJECT NUMBER: 2017-019

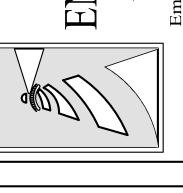DRAWING NUMBER: C-3

